Proposed Artificial Surf Reef 19th Ave, Palm Beach, Gold Coast



Contact: Shane Abel Email: shane.abel@canopy01.com Phone: 0427 564 235







CLIENT:			Rev.	AMENDMENT DESCRIPTION	DATE	PROPOSED ARTIFICIAL SURF REEF		
	CONTACT: Shane Abel		A ISSU	UED FOR REVIEW	21-06-2017	19th AVE, PALM BEACH 4221, GOLD COA	ST OHEENSLAND	
0 10 20 30 40 50mm	PHONE: 0427 564 235	127 564 235				LOCATION PLAN		
PRINT REDUCTION BAR A3 SHEET	ADDRESS: 8 Negara Cres, Goodwood	WAVERUSTERS				SCALE NOT TO SCALE	DRAWING NUMBER:	REVISION
ALL RIGHTS RESERVED AND SUBJECT TO GLOBAL PATENT. WAVEBUSTERS PTY LTD. ABN 33 602 202 433. NO REPRODUCTION UNLESS WRITTEN CONSENT GIVEN	TAS 7010	ARTIFICIAL SURF REEF TECHNOLOGY				DRAWN ALLAN WISE	C01	(A)





PROPOSED SITE PLAN


APPROXIMATE SCALE 1:5000

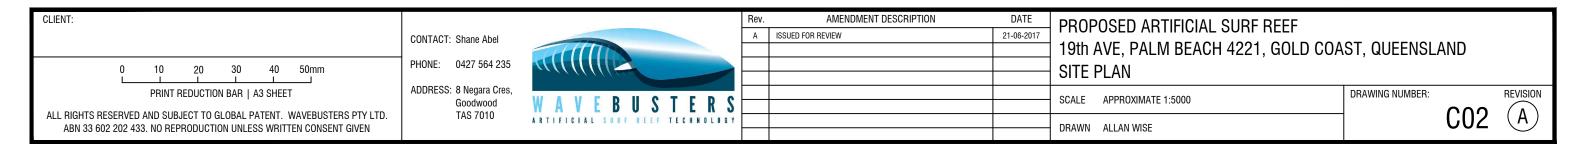


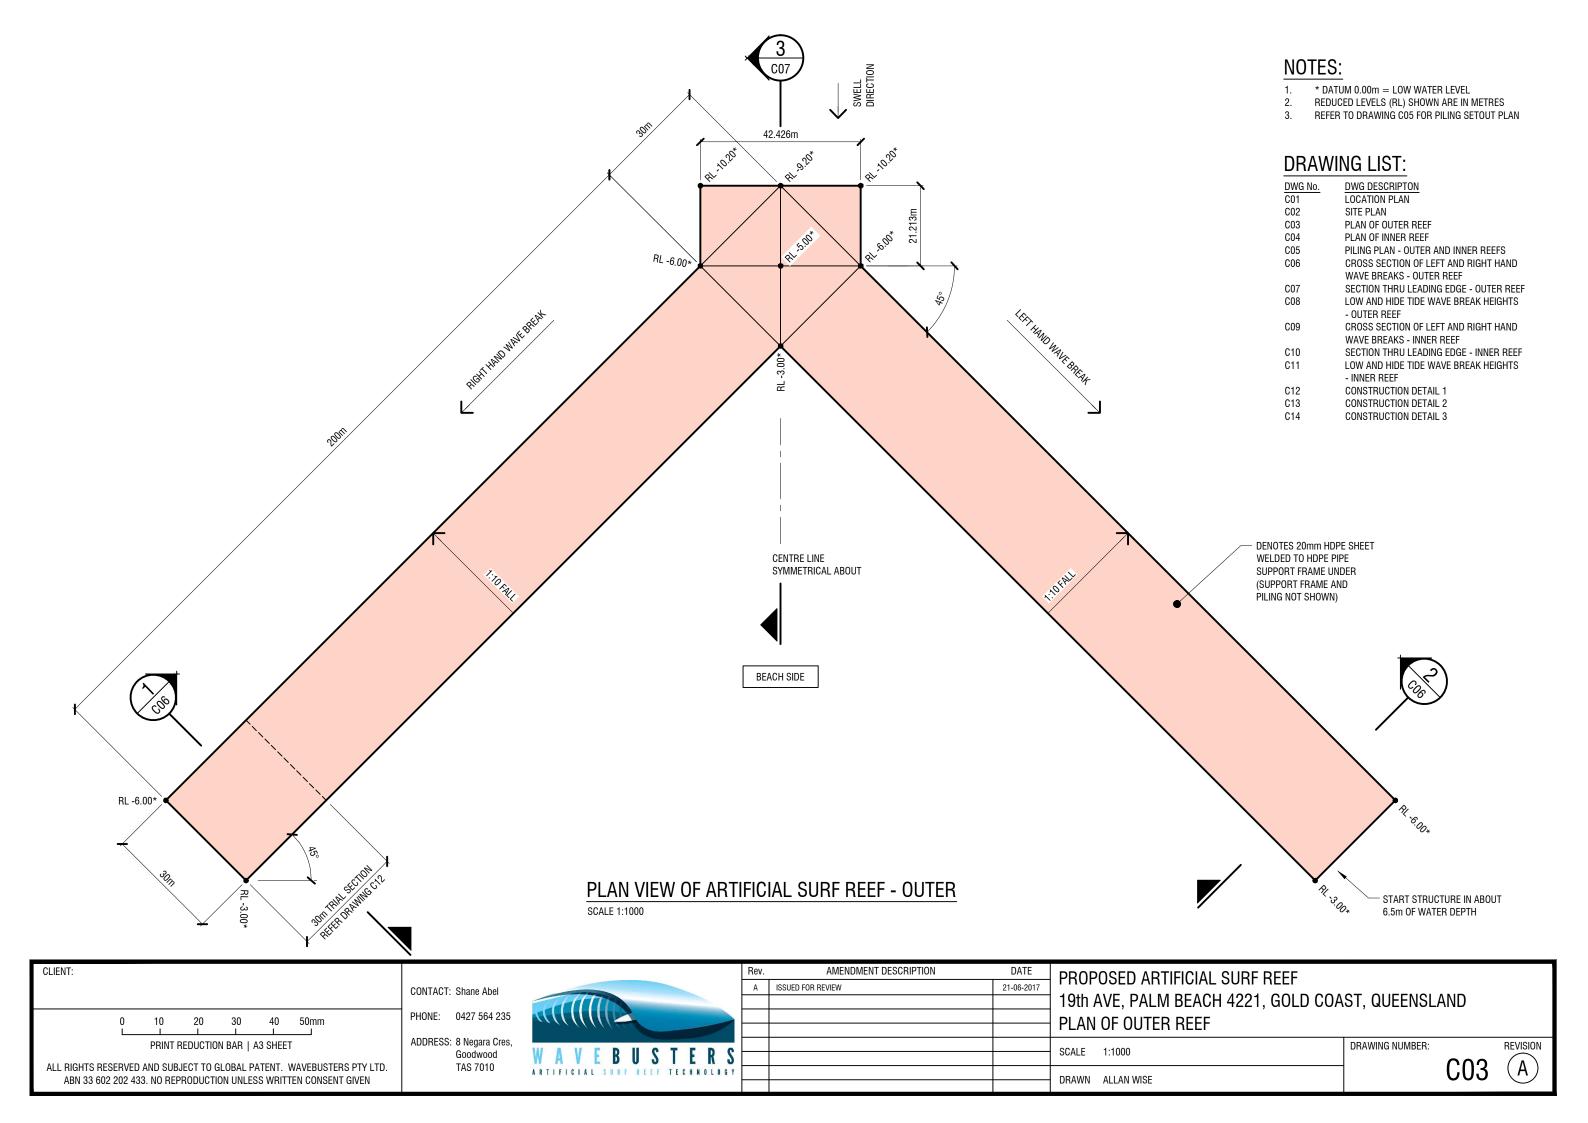

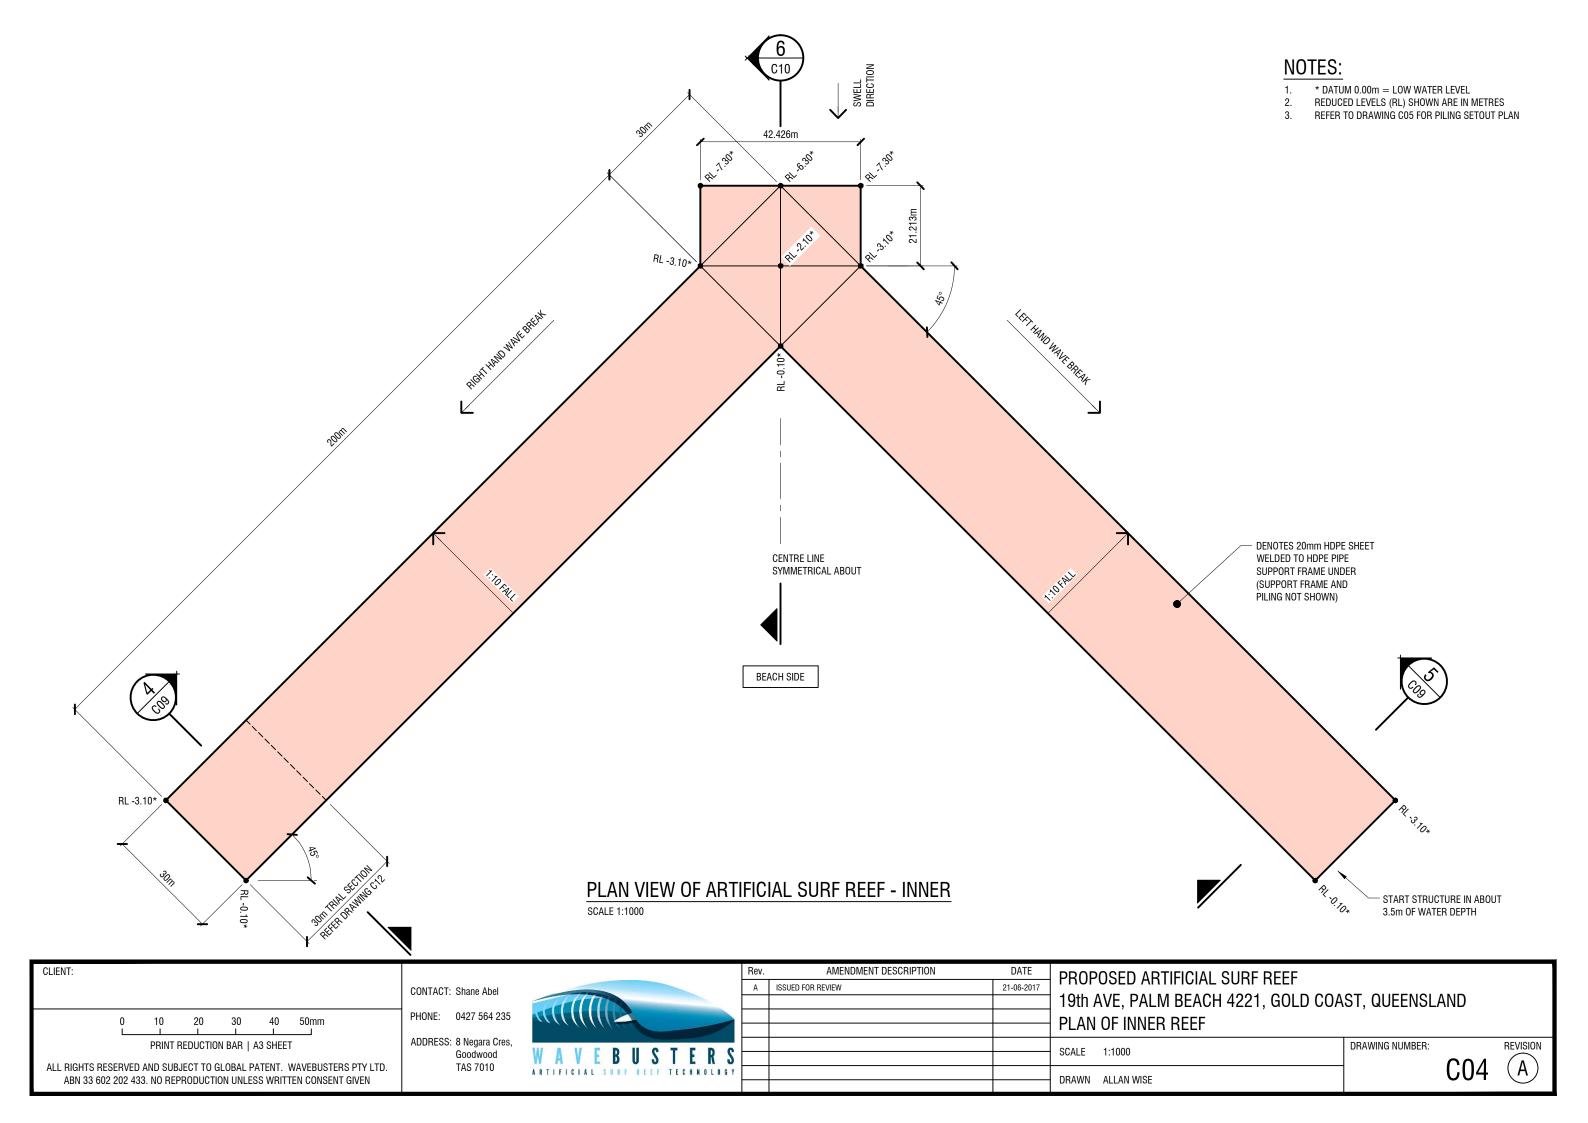

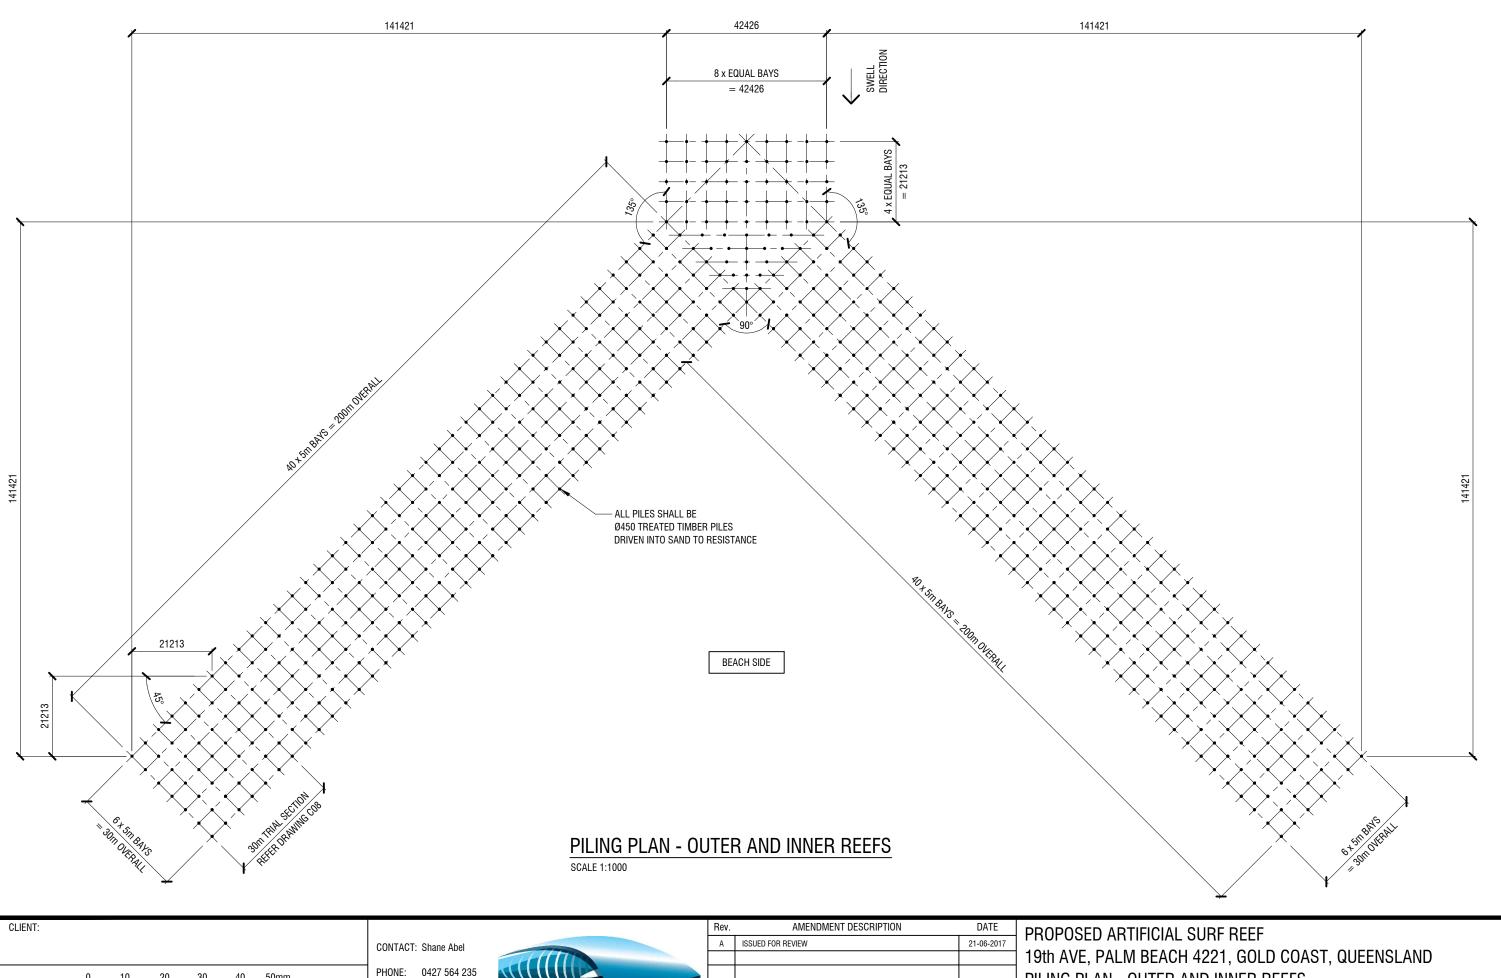

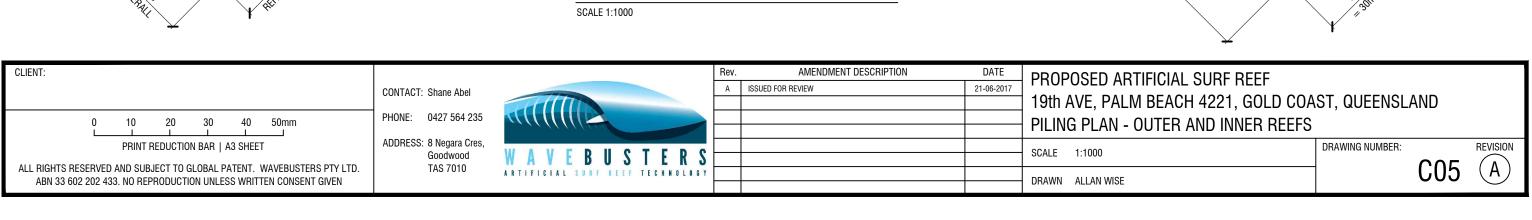


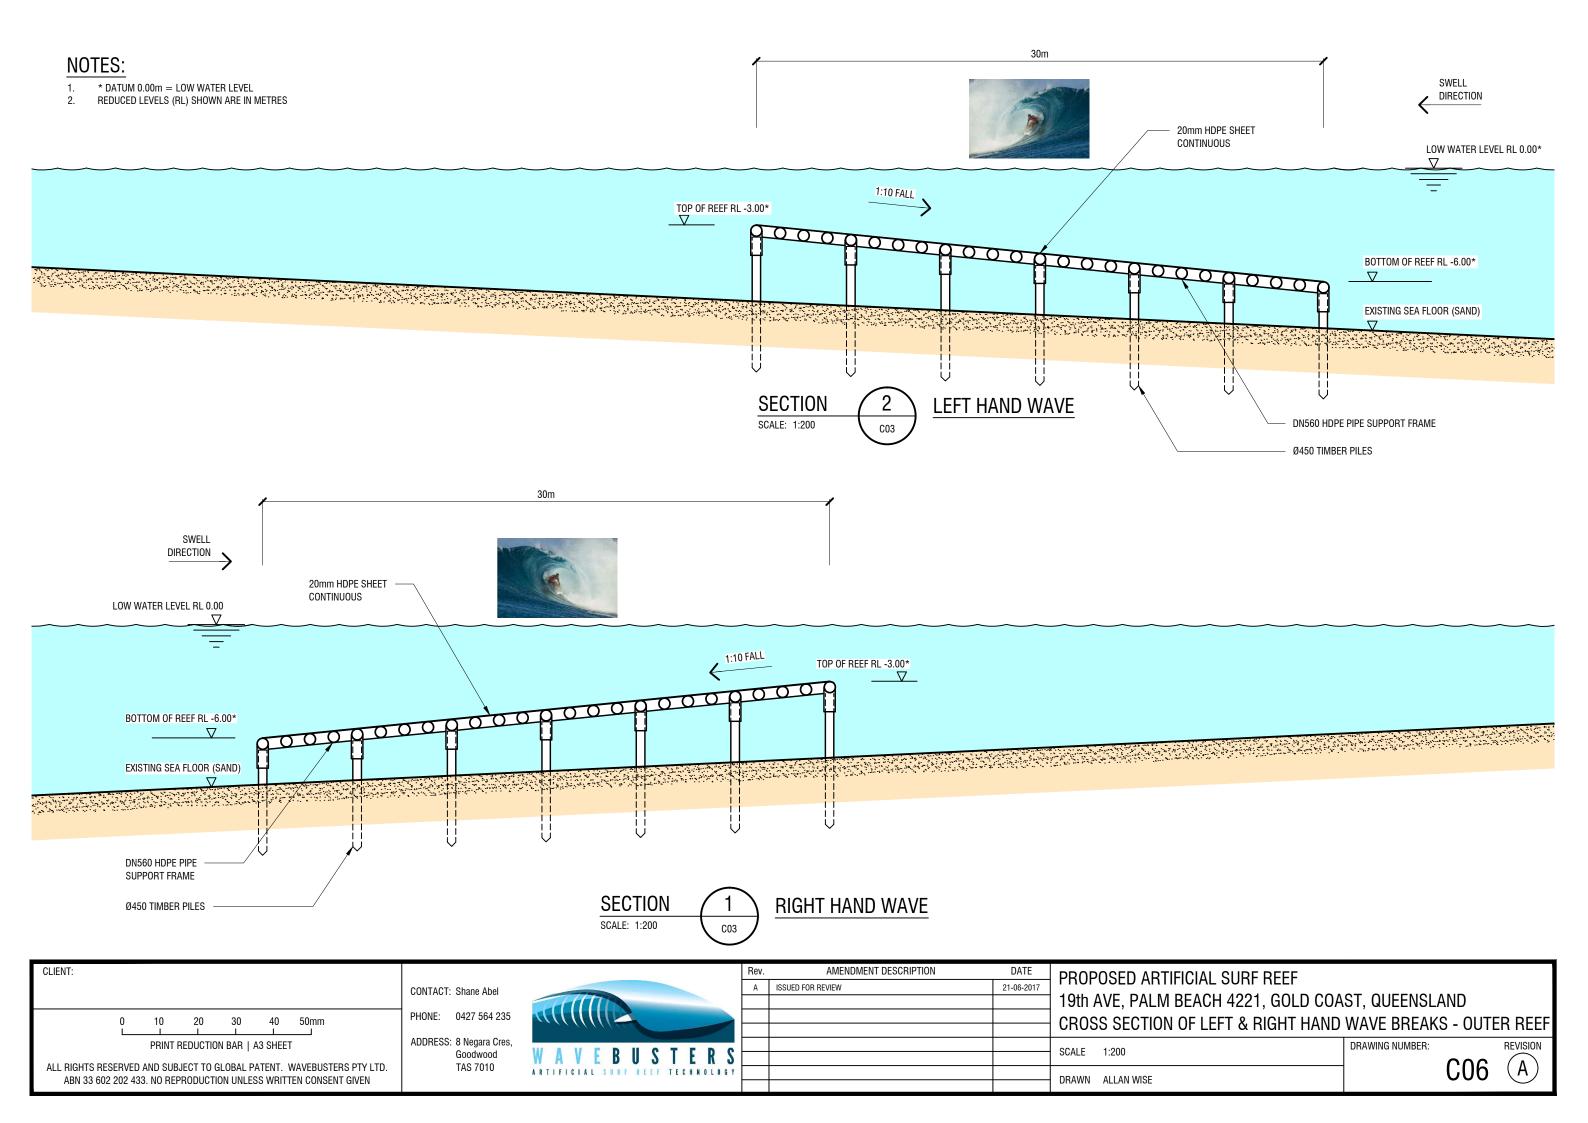


NOTES:

- * DATUM 0.00m = LOW WATER LEVEL
- P. REDUCED LEVELS (RL) SHOWN ARE IN METRES



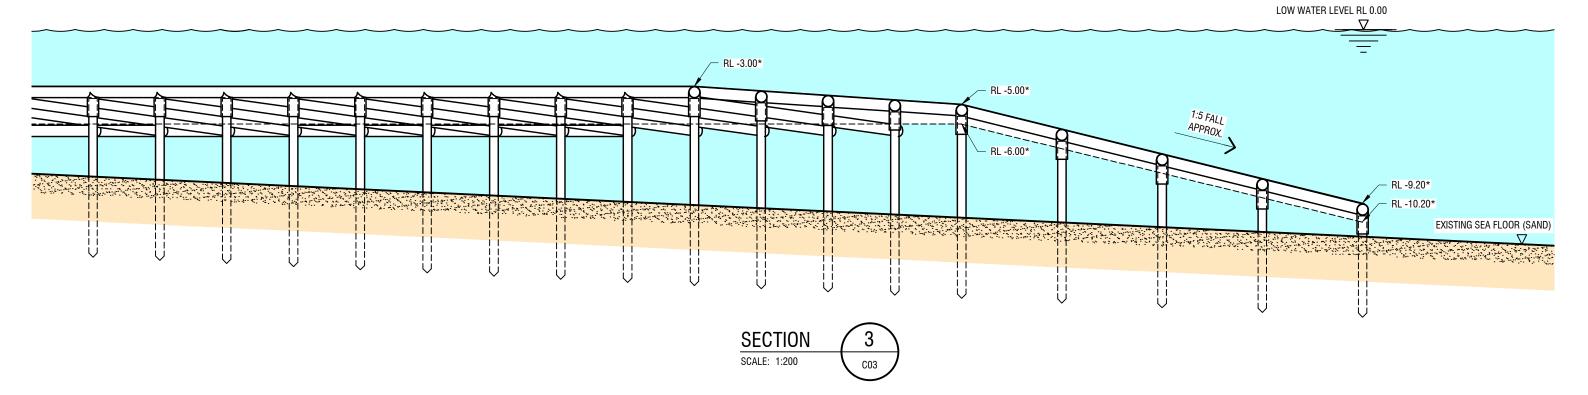


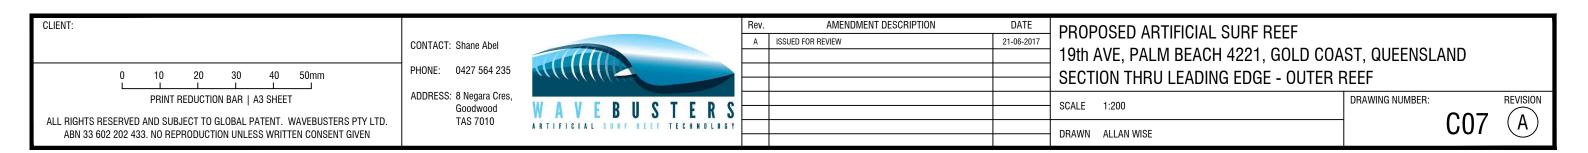

15m APPROXIMATE WAVE HEIGHTS AT THESE LOCATIONS AT LOW TIDE SWELL DIRECTION LOW WATER LEVEL RL 0.00* ροοροοροοροοροορ EXISTING SEA FLOOR (SAND)

LOW TIDE WAVE BREAKS - OUTER REEF

SCALE 1:200

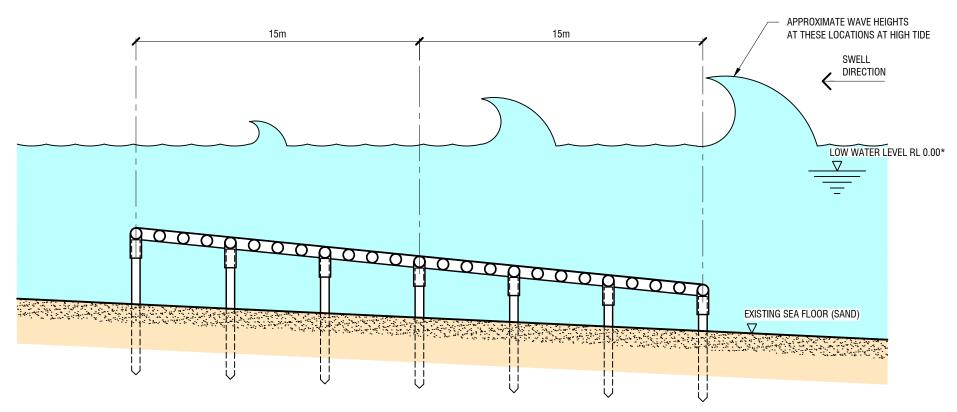


HIGH TIDE WAVE BREAKS - OUTER REEF

SCALE 1:200

CLIENT:			Rev.	AMENDMENT DESCRIPTION	DATE	PROPOSED ARTIFICIAL SURF REEF		
	CONTACT: Shane Abel		A ISS	UED FOR REVIEW	21-06-2017			
] 19th AVE, PALM BEACH 4221, GOLD COA	ST, QUEENSLAND	
0 10 20 30 40 50mm	PHONE: 0427 564 235					LOW AND HIDE TIDE WAVE BREAK HEIGH	TS _ OUTER REFE	
						LOW AND HIDE HDE WAVE DILEAR HEIGH	110 - OUTLIN INLLI	
PRINT REDUCTION BAR A3 SHEET	ADDRESS: 8 Negara Cres,	WAVEDHETEDE				SCALE 1:200	DRAWING NUMBER: REVISION	ON
ALL RIGHTS RESERVED AND SUBJECT TO GLOBAL PATENT. WAVEBUSTERS PTY LTD.	Goodwood TAS 7010	M A A F B A 2 I F K 2					$coo(\sqrt{\lambda})$	\
ABN 33 602 202 433. NO REPRODUCTION UNLESS WRITTEN CONSENT GIVEN	1707010	ARTIFICIAL SURF REEF TECHNOLOGY				DRAWN ALLAN WISE	C08 (A	ノ


NOTES:


- * DATUM 0.00m = LOW WATER LEVEL REDUCED LEVELS (RL) SHOWN ARE IN METRES
- 3. WAVE BREAK FORMULA: 1.4 x WAVE HEIGHT DEPTH OR 1m WAVE BREAKS IN 1.4m WATER DEPTH

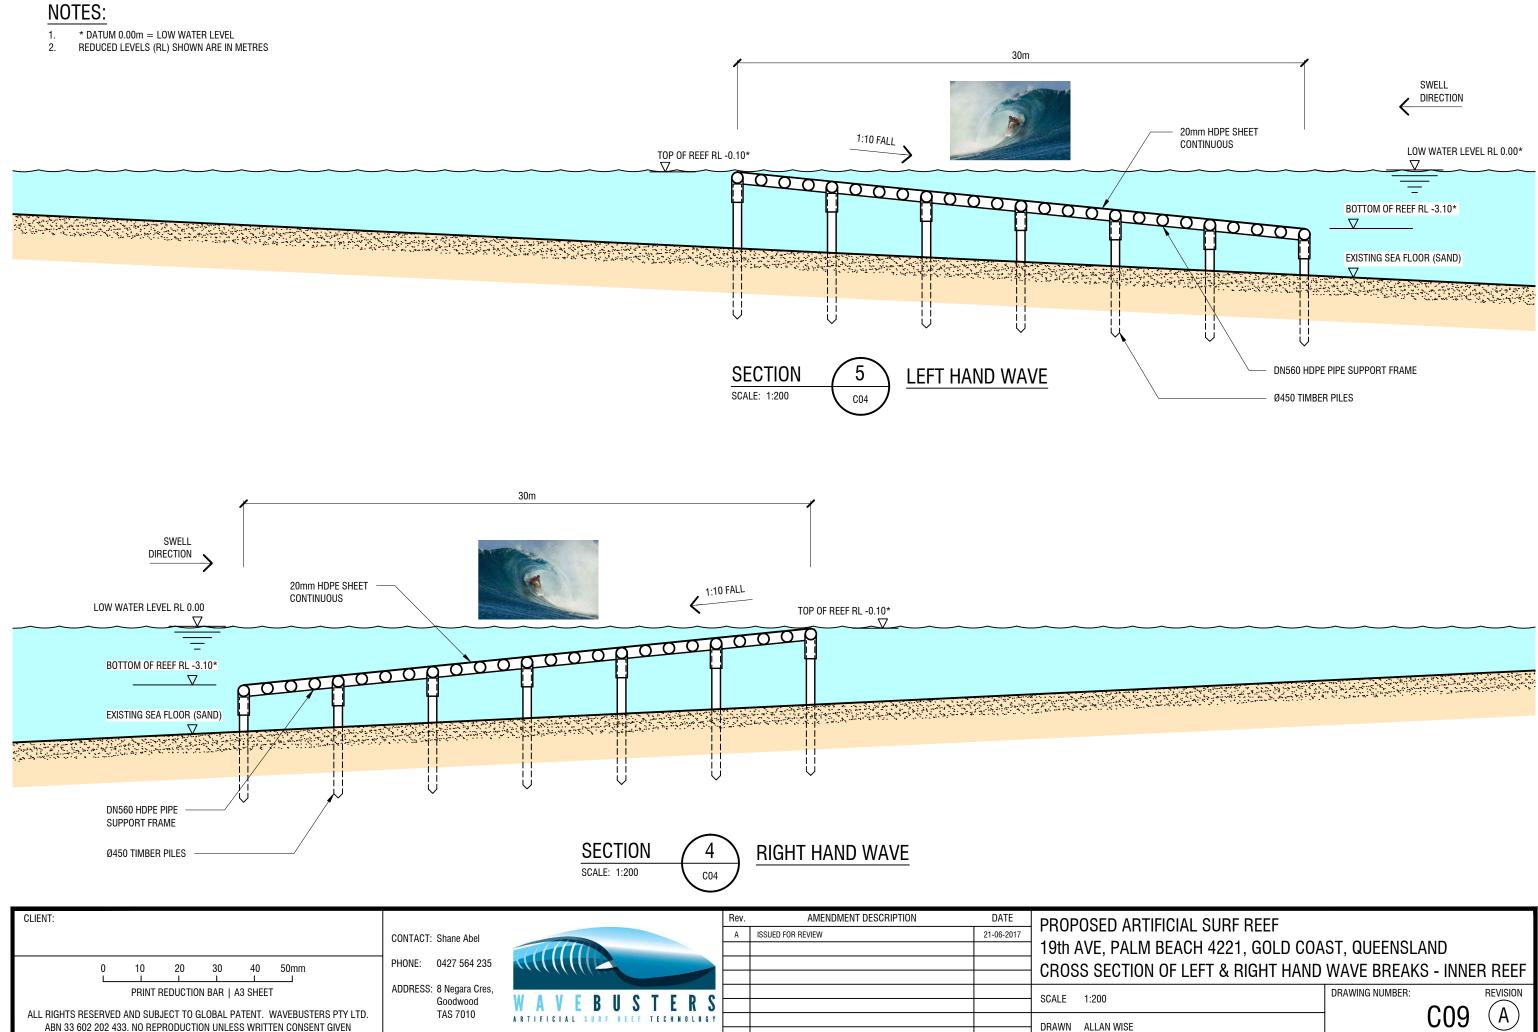


NOTES:

- * DATUM 0.00m = LOW WATER LEVEL
- REDUCED LEVELS (RL) SHOWN ARE IN METRES

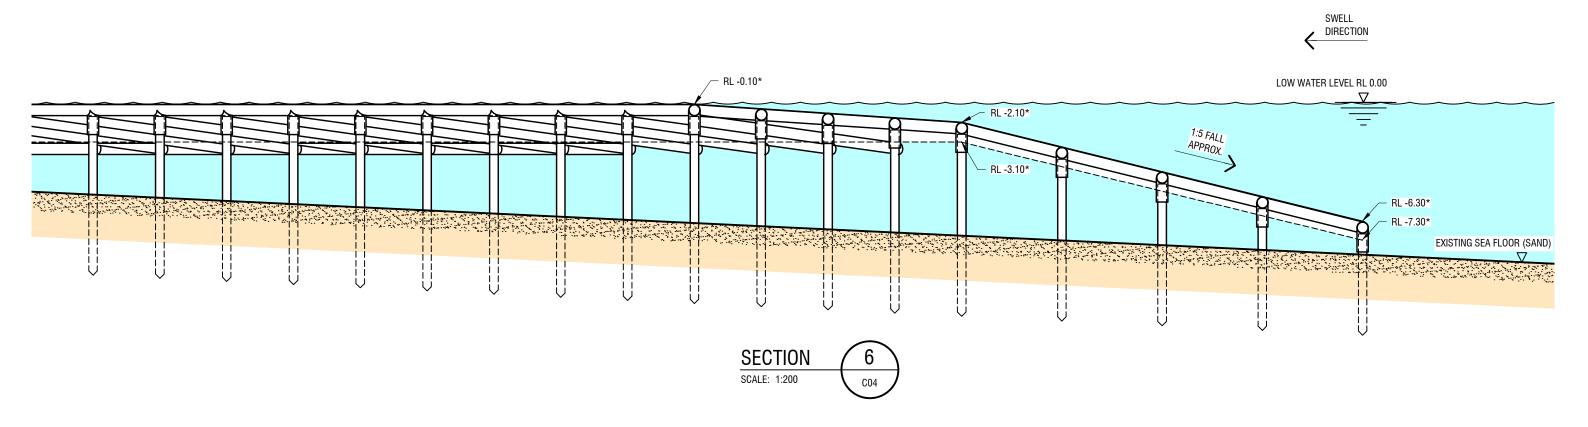

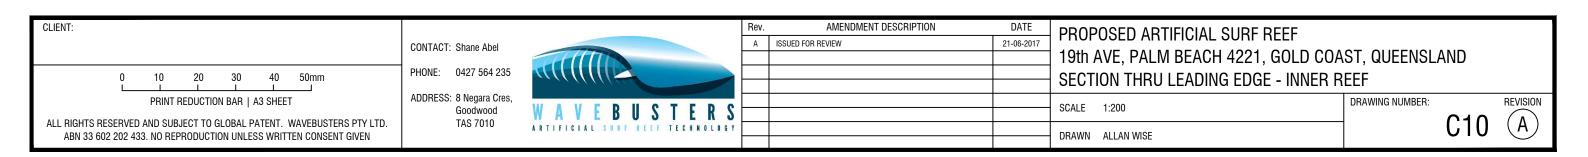

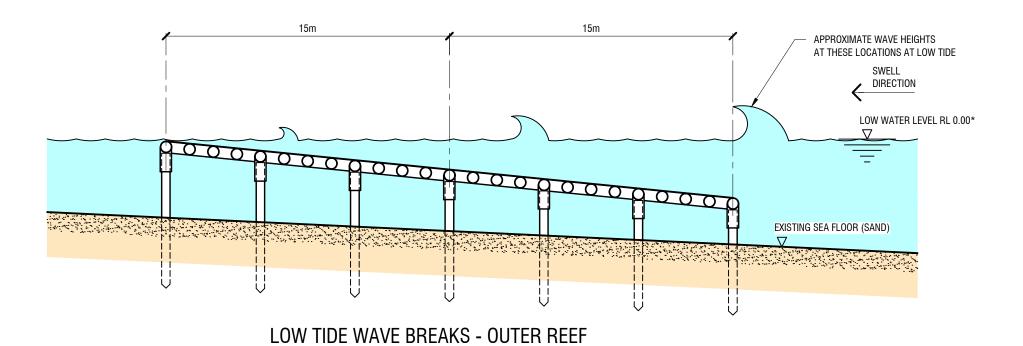

NOTES:

* DATUM 0.00m = LOW WATER LEVEL REDUCED LEVELS (RL) SHOWN ARE IN METRES WAVE BREAK FORMULA: 1.4 x WAVE HEIGHT DEPTH

OR 1m WAVE BREAKS IN 1.4m WATER DEPTH

15m 15m APPROXIMATE WAVE HEIGHTS AT THESE LOCATIONS AT HIGH TIDE

SWELL DIRECTION

LOW WATER LEVEL RL 0.00*


EXISTING SEA FLOOR (SAND)

HIGH TIDE WAVE BREAKS - OUTER REEF

SCALE 1:200

SCALE 1:200

CLIENT:		Rev. AMENDMENT DESCRIPTION DATE	DDODOCED ADTIFICIAL CUDE DEFE
	CONTACT: Shane Abel	A ISSUED FOR REVIEW 21-06-2017	PROPOSED ARTIFICIAL SURF REEF
	CONTACT. Shalle Abel		1 19th Ave, Palm Beach 4221, Gold Coast, Queensland
0 10 20 30 40 50mm	PHONE: 0427 564 235		LOW AND HIDE TIDE WAVE BREAK HEIGHTS - INNER REEF
PRINT REDUCTION BAR A3 SHEET	ADDRESS: 8 Negara Cres,		SCALE 1:200 DRAWING NUMBER: REVISION
ALL RIGHTS RESERVED AND SUBJECT TO GLOBAL PATENT. WAVEBUSTERS PTY LTD.	Goodwood WAVEBUSTERS		C11 A
ABN 33 602 202 433. NO REPRODUCTION UNLESS WRITTEN CONSENT GIVEN	ARTIFICIAL SURF REEF TECHNOLOGY		DRAWN ALLAN WISE

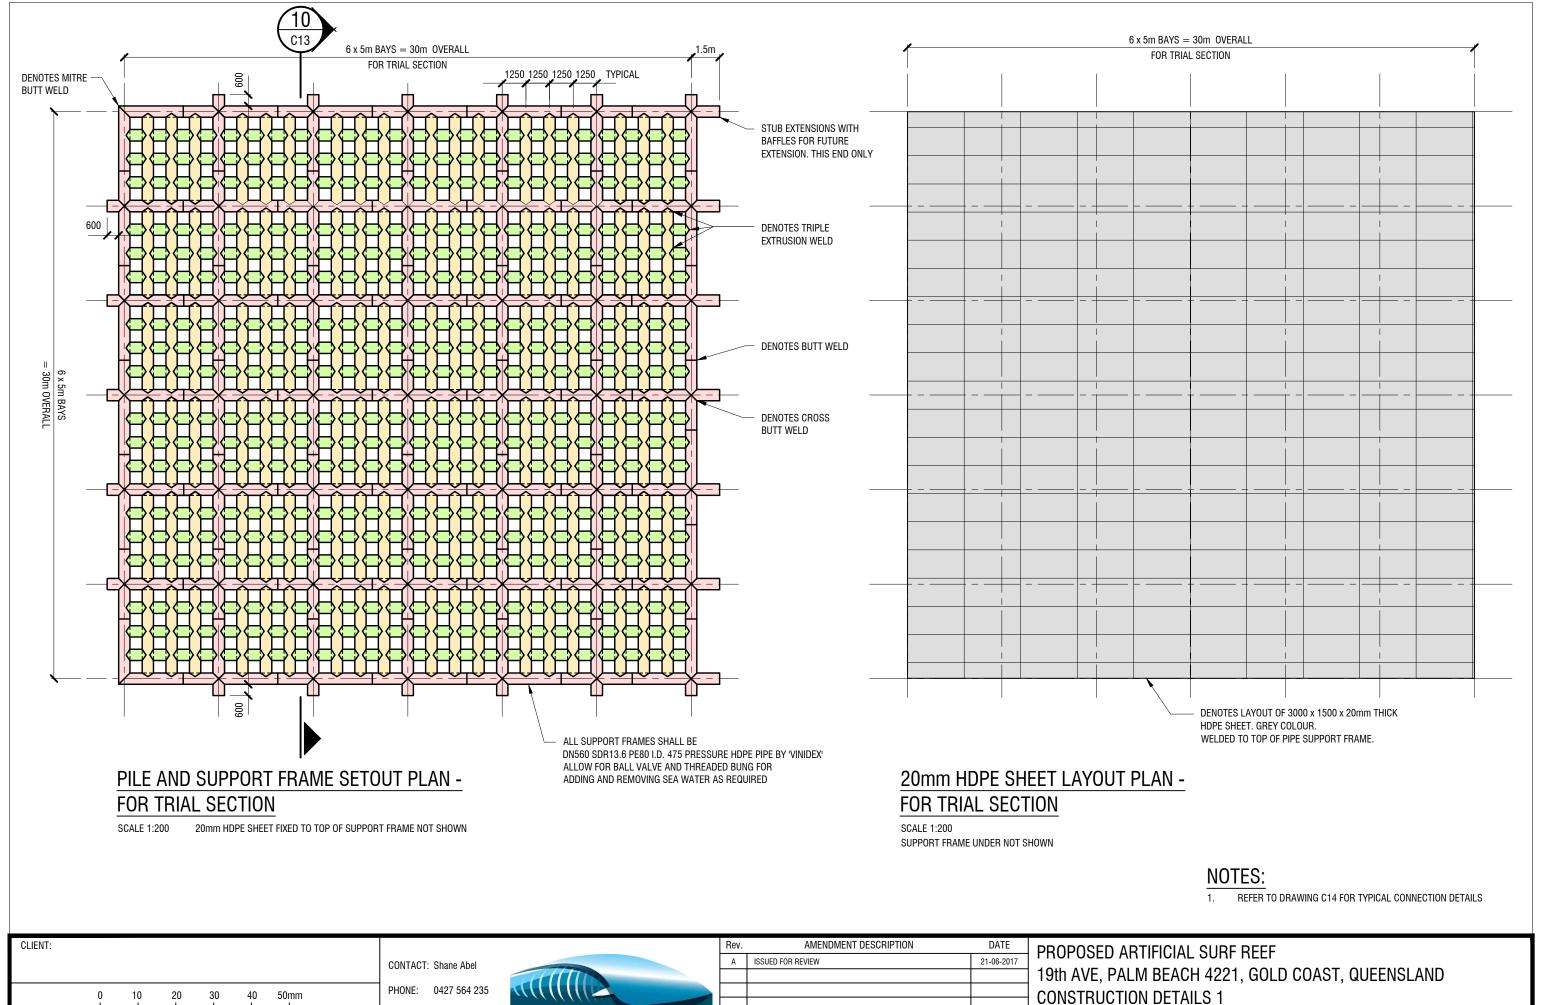

CONTACT: Shane Abel

PRINT REDUCTION BAR | A3 SHEET

ABN 33 602 202 433. NO REPRODUCTION UNLESS WRITTEN CONSENT GIVEN

CONTACT: Shane Abel

PHONE: 0427 564 235

ADRESS: 8 Negara Cres, Goodwood TAS 7010

ALL RIGHTS RESERVED AND SUBJECT TO GLOBAL PATENT. WAVEBUSTERS PTY LTD. ABN 33 602 202 433. NO REPRODUCTION UNLESS WRITTEN CONSENT GIVEN

CONTACT: Shane Abel

PHONE: 0427 564 235

ADRESS: 8 Negara Cres, Goodwood TAS 7010

WAVEBUSTERS

TO DRAWN ALLAN WISE

PROPOSED ARTIFICIAL SURF REEF

19th AVE, PALM BEACH 4221, GOLD COAST, QUEENSLAND

CONSTRUCTION DETAILS 1

PROPOSED ARTIFICIAL SURF REEF

19th AVE, PALM BEACH 4221, GOLD COAST, QUEENSLAND

CONSTRUCTION DETAILS 1


PRAWN ALLAN WISE

CONTACT: Shane Abel


PHONE: 0427 564 235


ADRESS: 8 Negara Cres, Goodwood TAS 7010

TAS

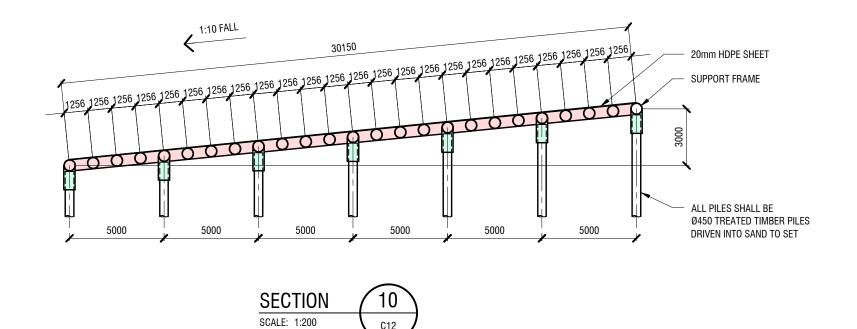


C12

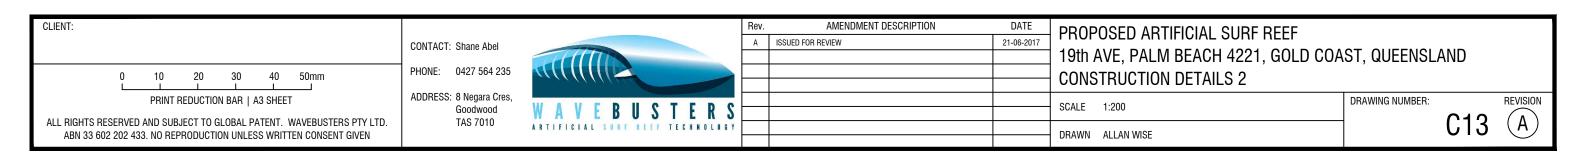

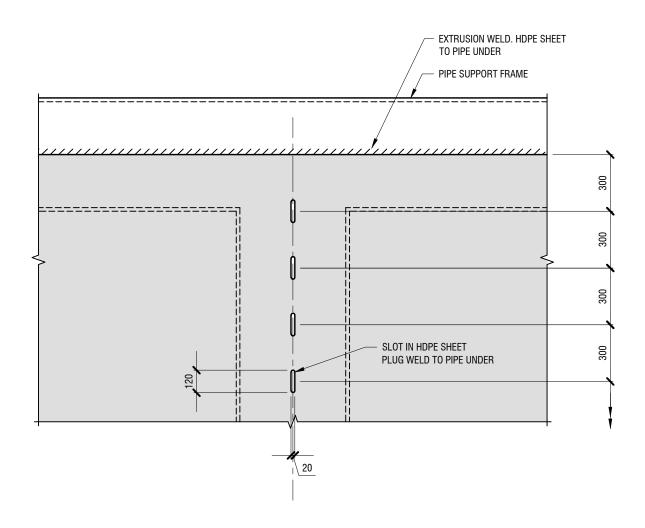


TYPICAL HDPE SHEET TO SUPPORT FRAME CONNECTION - PLAN VIEW

SCALE 1:20
THIS WELD PATTERN REPEATS OVER ENTIRE FRAME

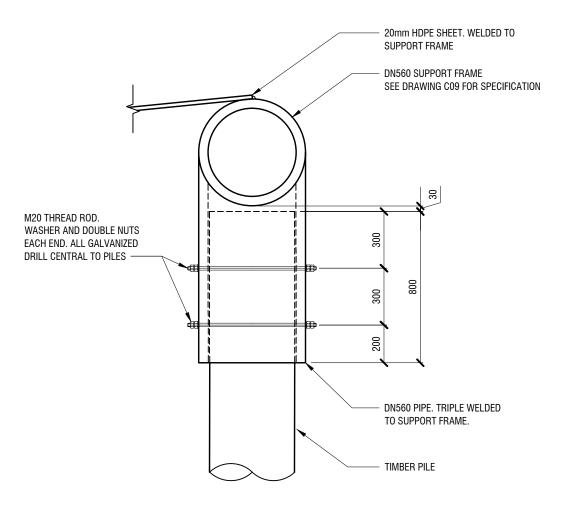

TYPICAL PILE TO SUPPORT FRAME CONNECTION DETAIL

SCALE 1:2

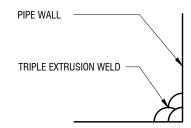

TYPICAL TRIPLE WELD DETAIL

NOT TO SCALE

